



STAGINO	FLAN LEGEND	START:	FINISH:		
	PHASE 1 - ABATEMENT *	1/18/17	1/24/17		
	PHASE 1 - CONSTRUCTION	1/25/17	2/21/17		
	PHASE 2 - CONSTRUCTION	2/24/17	3/23/17		
	PHASE 3 - CONSTRUCTION	3/28/17	4/24/17		

COORDINATE SCHEDULE.

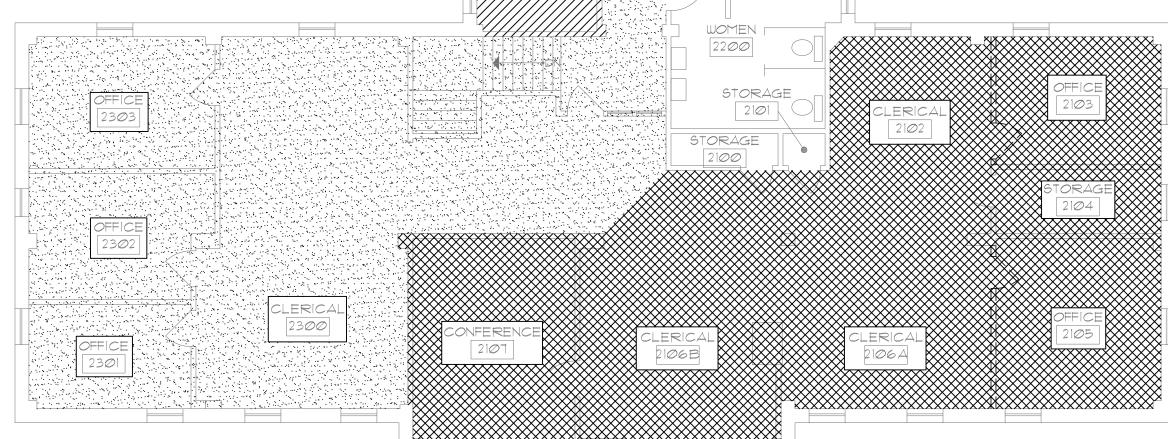



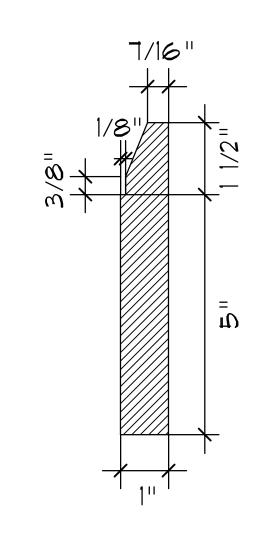

2 WOOD WALL BASE DETAIL
AI) SCALE:6" = 1-0"

	ROOM FINISH SCHEDULE															
Ī		0. ROOM	FLOOR		BASE BOARD			MALL			CEILING		CEILING			
	NO.		EXISTING	NEM	NORTH	SOUTH	EAST	MEST	NORTH	SOUTH	EAST	MEST	EXISTING	NEM	HEIGHT	REMARKS
1	2100	STORAGE	TERR.										EXIST.		MATCH EXIST.	
Ī	2101	STORAGE	TERR.										EXIST.		MATCH EXIST.	
Ī	2102	CLERICAL	MD T&G*	CAR. *	MD		VINYL	ND	P.T.		P.T.	P.T.	DEMO A.C.T.	A.C.T.	MATCH EXIST.	*FEATHER OUT FLOOR AT TERR. WITH HYDAULIC CEMENT. SEE 2 ON A.2.
-	2103	OFFICE	ND T&G	CAR.	VINYL	ΝD	VINYL	VINYL	P.T.	P.T.	P.T.	P.T.	DEMO A.C.T.	A.C.T.	MATCH EXIST.	
{	2104	STORAGE	TERR.										EXIST.		MATCH EXIST.	
-	2105	OFFICE	ND T&G	CAR.	VINYL	VINYL	VINYL	VINYL	P.T.	P.T.	P.T.	P.T.	DEMO A.C.T.	A.C.T.	MATCH EXIST.	
ļ	2106A	CLERICAL	DEMO CONC.	CAR. **		ND	VINYL	MD		P.T.	P.T.	P.T.	DEMO A.C.T.	A.C.T.	MATCH EXIST.	**INSTALL 3/4" T&G PLYMOOD AND SELF LEVELING CONC. TOPPING
ļ	2106B	CLERICAL	ND T&G*	CAR. *	VINYL	VINYL	VINYL	ND		P.T.	P.T.	P.T.	DEMO A.C.T.	A.C.T.	MATCH EXIST.	*FEATHER OUT FLOOR AT TERR. WITH HYDAULIC CEMENT. SEE 2 ON A.2.
ŀ	2107	CONFERENCE	MD T&G	CAR.	MD	ND	ND	ND	P.T.	P.T.	P.T.	P.T.	DEMO A.C.T.	A.C.T.	MATCH EXIST.	THE SELECTION OF THE COLUMN TO SELECTION OF THE
	2300	CLERICAL	MD T&G*	CAR. *	ND	ND	VINYL	VINYL	P.T.	P.T.	P.T.	P.T.	DEMO A.C.T.	A.C.T.	MATCH EXIST.	*FEATHER OUT FLOOR AT TERR. WITH HYDAULIC CEMENT. SEE 2 ON A.2.
, 	2301	OFFICE	MD T&G	CAR.	YINYL	VINYL	VINYL	VINYL	P.T.	P.T.	P.T.	P.T.	DEMO A.C.T.	A.C.T.	MATCH EXIST.	THE DAOLIO GLIMLINI. SEL [2] ON A.2.
<u> </u>	2302	OFFICE	ND T&G	CAR.	VINYL	VINYL	VINYL	VINYL	P.T.	P.T.	P.T.	P.T.	DEMO A.C.T.	A.C.T.	MATCH EXIST.	
ŀ	2303	OFFICE	ND T&G	CAR.	VINYL	VINYL	VINYL	VINYL	P.T.	P.T.	P.T.	P.T.	DEMO A.C.T.	A.C.T.	MATCH EXIST.	
	2201	CONFERENCE	ND T&G*	CAR. *	VINYL	VINYL	ND	MD	P.T.	P.T.	P.T.	P.T.	DEMO A.C.T.	A.C.T.	MATCH	*FEATHER OUT FLOOR AT TERR. WITH HYDAULIC CEMENT. SEE 2 ON A.2.
,	2202	OFFICE	MD T&G	CAR.	VINYL	ND	VINYL	VINYL	P.T.	P.T.	P.T.	P.T.	DEMO A.C.T.	A.C.T.	EXIST. MATCH	FI DAULIC CEMENT. SEE [4] ON A.2.
; -	2203	OFFICE	MD T&G	CAR.	VINYL	VINYL	VINYL	ND	P.T.	P.T.	P.T.	P.T.	DEMO A.C.T.	A.C.T.	EXIST. MATCH	
<u> </u>	2204	OFFICE	MD T&G	CAR.	VINYL	VINYL	ND	VINYL	P.T.	P.T.	P.T.	P.T.	DEMO A.C.T.	A.C.T.	EXIST. MATCH	
_		STAIRS	DEMO TREADS	NEW TREADS	VINYL	VINYL	VINYL	VINYL	P.T.	P.T.	P.T.	P.T.	DEMO A.C.T.	A.C.T.	EXIST. MATCH EXIST.	

* 9. PAINT ALL WALL SURFACES, WOOD BASE BOARD, DOOR FRAMES, CASING, INTERIOR SIDE OF WINDOW SASH IN ALL AREAS IDENTIFIED ON THE ROOM FINISH SCHEDULE.

GENERAL NOTES:

1. ALL EXISTING CONSTRUCTION / FINISHES DISTURBED DURING CONSTRUCTION SHALL BE RESTORED TO A CONDITION AT LEAST EQUAL IN MATERIAL AND APPEARANCE TO THAT WHICH EXISTED BEFORE CONSTRUCTION BEGAN.

2. CONTRACTOR SHALL FIELD VERIFY ALL EXISTING DIMENSIONS AND CONDITIONS, NOTIFY ARCHITECT/ENGINEER OF ANY DISCREPANCIES WHICH MAY AFFECT THE OUTCOME OF THE WORK

3. DUE TO AGE OF BUILDING IT IS ASSUMED THAT EXISTING PAINTED SURFACES CONTAIN LEAD BASED PAINT. CONTRACTOR IS RESPONSIBLE FOR INFORMING ALL ON SITE PERSONNEL OF THIS POTENTIAL AND SHALL COMPLY WITH ALL APPLICABLE STATE AND FEDERAL REQUIREMENTS.

4. EXISTING WALLS WHERE DOORS HAVE BEEN REMOVED ARE TO BE PATCHED AND PAINTED.

5. WALLS TO RECEIVE PAINT ARE TO BE PREPARED, PATCHED AND PAINTED FROM CORNER TO CORNER

6. KEEP EXISTING SMOKE AND HEAT DETECTORS CONNECTED DURING CONSTRUCTION AND RE-USE IN NEW CEILING INSTALLATION.

1. ALL WIRELESS ROUTERS, NETWORK CABLES, AND MISCELLANEOUS NETWORK EQUIPMENT TO REMAIN IN PLACE - SEE ELECTRICAL SHEETS FOR MORE INFORMATION.

8. PAINT ALL WALL SURFACES, WOOD BASE BOARD, DOOR FRAMES, CASING, INTERIOR SIDE OF WINDOW SASH IN ALL AREAS IDENTIFIED ON THE ROOM FINISH SCHEDULE.

100 EAST WASHINGTON, SUITE 220 BELLEVILLE, IL 62220 TEL 618.277.5200 FAX 618.277.5227


SIGNED: 12-22-16 CABVIN A EXPIRES: 11-30-2018

12/22/16

CHECK: MGN MGN PROJECT PHASE:

BID DOCUMENTS AAIC PROJECT NUMBER:

16011 SHEET NUMBER:

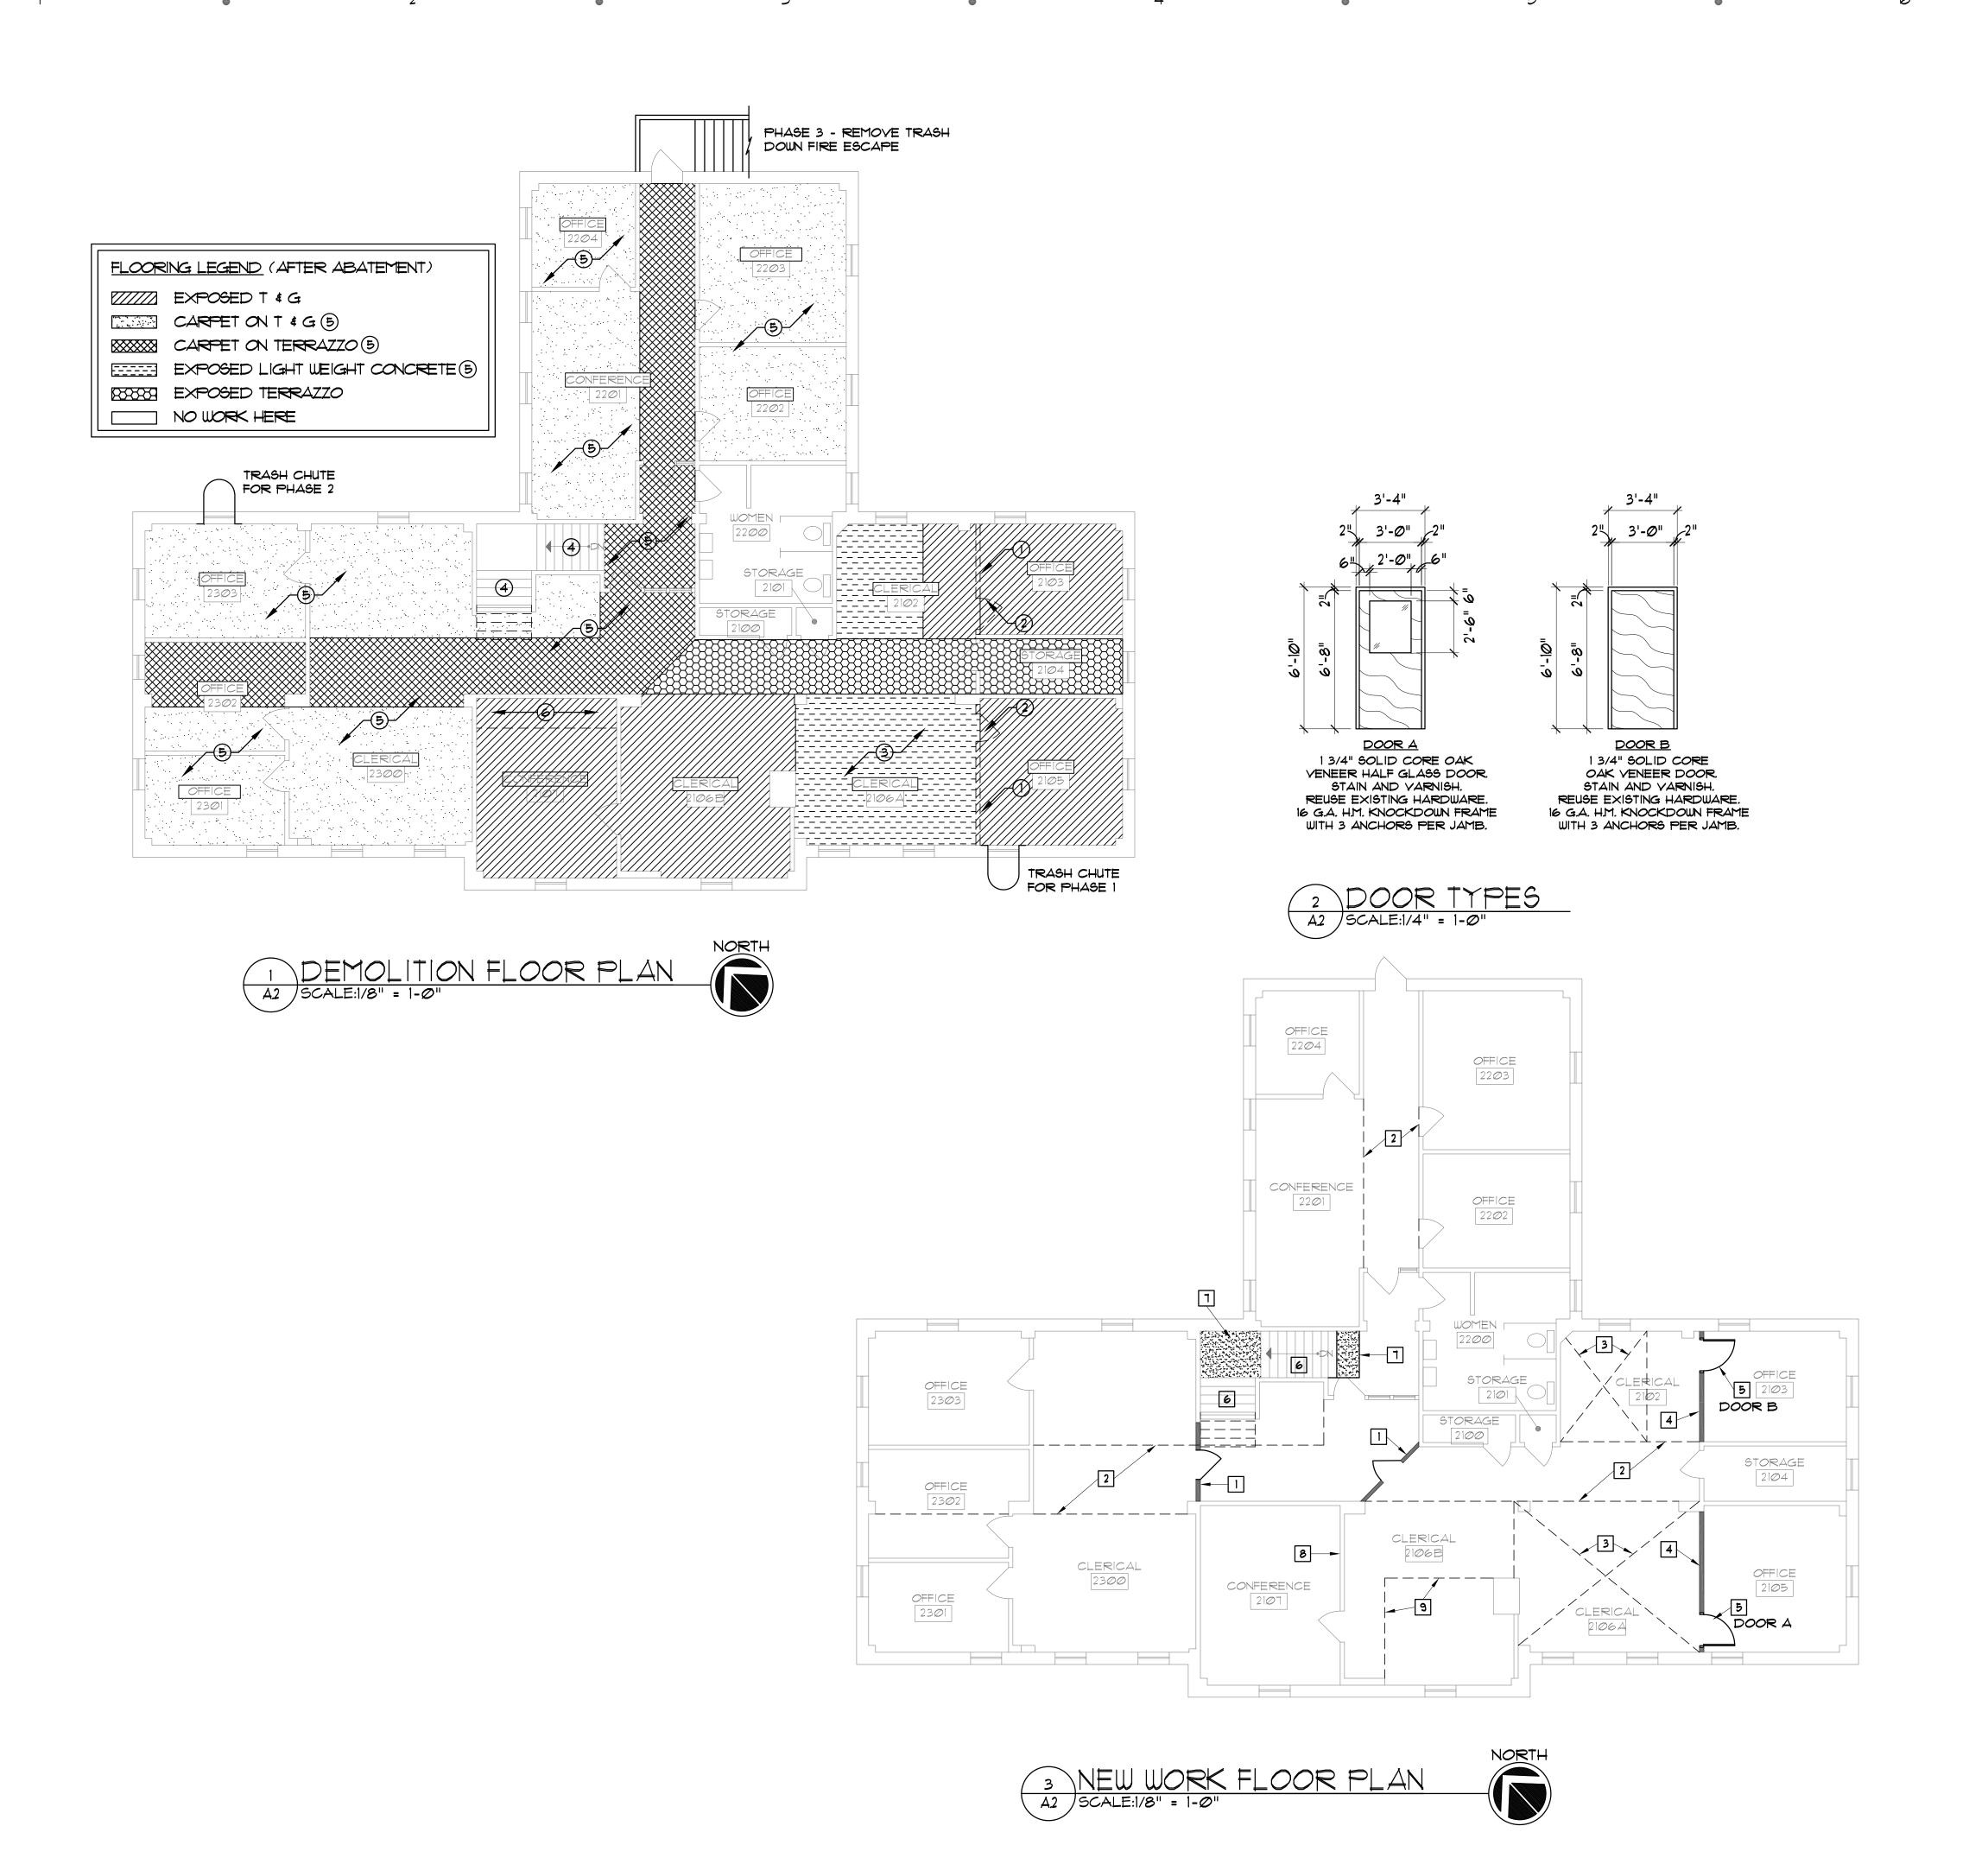

DEMOLITION NOTES:

- (1) ABATEMENT CONTRACTOR TO REMOVE WALL PARTITION.
- ABATEMENT CONTRACTOR TO REMOVE AND SALVAGE
 DOOR AND ALL HARDWARE. GIVE TO GENERAL
 CONTRACTOR FOR REINSTALLATION.
- 3) GENERAL CONTRACTOR TO REMOVE APPROXIMATELY 1 1/2" OF LIGHT WEIGHT CONCRETE IN THIS AREA.
- 4) REMOVE EXISTING RUBBER TREADS, TERRAZZO RISERS TO REMAIN.
- 5 REMOVE EXISTING CARPET.
- (6) CASEWORK REMOVED BY OTHERS.

NEW WORK NOTES:

- EDGE OF EXISTING TERRAZZO UNDERLAYMENT TO REMAIN. FEATHER ADJACENT FLOOR TO MATCH TERRAZZO AS NEEDED WITH HYDRAULIC CEMENT.
- 3 T&G SUBFLOOR TO BE REMOVED BY ABATEMENT CONTRACTOR GENERAL CONTRACTOR TO REMOVE APPROXIMATELY I 1/2" OF LIGHT WEIGHT CONCRETE AND INSTALL NEW 3/4" T&G PLYWOOD SUB FLOOR AND SELF-LEVELING HYDRAULIC CEMENT TO BRING THE FLOOR LEVEL UP TO SURROUNDING LEVEL APPROXIMATELY I 1/2" THICK
- 4 NEW 2X4 @ 16" O.C. STUD PARTITION WITH 5/8" FIRE CODE GYPSUM BOARD ON EACH SIDE.
- 5 NEW WOOD DOOR IN NEW HM. FRAME. REINSTALL EXISTING HARDWARE.
- 6 REPLACE EXISTING RUBBER TREADS WITH NEW RUBBER TREADS WITH ANTI-SLIP NOSING STRIPS, INSTALL DURING NON BUSINESS HOURS ALLOW FOR CURE TIME.
- 1 NEW A.D.A. TACTAL WARNING PADS.
- 8 DO NOT PAINT OVER EXISTING PROJECTION SCREEN PAINTED SURFACE.
- 9 EXISTING UNEVEN FLOOR CONTRACTOR TO LEVEL OUT WITH HYDRAULIC CEMENT. ASSUME AN AVERAGE OF 3/4" THICK IN THIS AREA.

GENERAL NOTES:

- I. ALL EXISTING CONSTRUCTION / FINISHES DISTURBED DURING CONSTRUCTION SHALL BE RESTORED TO A CONDITION AT LEAST EQUAL IN MATERIAL AND APPEARANCE TO THAT WHICH EXISTED BEFORE CONSTRUCTION BEGAN.
- 2. CONTRACTOR SHALL FIELD VERIFY ALL EXISTING DIMENSIONS AND CONDITIONS. NOTIFY ARCHITECT/ENGINEER OF ANY DISCREPANCIES WHICH MAY AFFECT THE OUTCOME OF THE WORK.
- 3. DUE TO AGE OF BUILDING IT IS ASSUMED THAT EXISTING PAINTED SURFACES CONTAIN LEAD BASED PAINT. CONTRACTOR IS RESPONSIBLE FOR INFORMING ALL ON SITE PERSONNEL OF THIS POTENTIAL AND SHALL COMPLY WITH ALL APPLICABLE STATE AND FEDERAL REQUIREMENTS.
- 4. EXISTING WALLS WHERE DOORS HAVE BEEN REMOVED ARE TO BE PATCHED AND PAINTED.
- 5. WALLS TO RECEIVE PAINT ARE TO BE PREPARED, PATCHED AND PAINTED FROM CORNER TO CORNER
- 6. KEEP EXISTING SMOKE AND HEAT DETECTORS
 CONNECTED DURING CONSTRUCTION AND RE-USE IN NEW
 CEILING INSTALLATION.
- T. ALL WIRELESS ROUTERS, NETWORK CABLES, AND MISCELLANEOUS NETWORK EQUIPMENT TO REMAIN IN PLACE SEE ELECTRICAL SHEETS FOR MORE INFORMATION.
- 8. PAINT ALL WALL SURFACES, WOOD BASE BOARD, DOOR FRAMES, CASING, INTERIOR SIDE OF WINDOW SASH IN ALL AREAS IDENTIFIED ON THE ROOM FINISH SCHEDULE.

NO.: DATE: REMARKS.

NO.: 25 50 75 100 12

DRIC
PARTNERSHIP, LLC
CONSULTING ENGINEERS

00 EAST WASHINGTON, SUITE 220
BELLEVILLE, IL 62220
TEL 618.277.5200
FAX 618.277.5227

52234 p 618.345.1270 f 618.345.1282 www.aaicinc.com

architects inter

ISTRATION BUILDING
OR RENOVATIONS
ITION & NEW WORK
PLANS

273 - ADMINIS
2ND FLOOR
PRAMING: DEMOLI

SIGNED: 12-22-16

OF 11.

CABVIN

C. MORRIS

O01-010501

EXPIRES: 11-30-2018

DATE:

12/22/16

EXPIRES: 11-30-2018

DATE:

12/22/16

DRAWN: APP:

ALP MGN

CHECK: APP:

MGN

MGN MGN

PROJECT PHASE:

BID

DOCUMENTS

DOCUMENTS

AAIC PROJECT NUMBER:


AIC PROJECT NUMBER:

16011

SHEET NUMBER:

OF 10 SHEETS



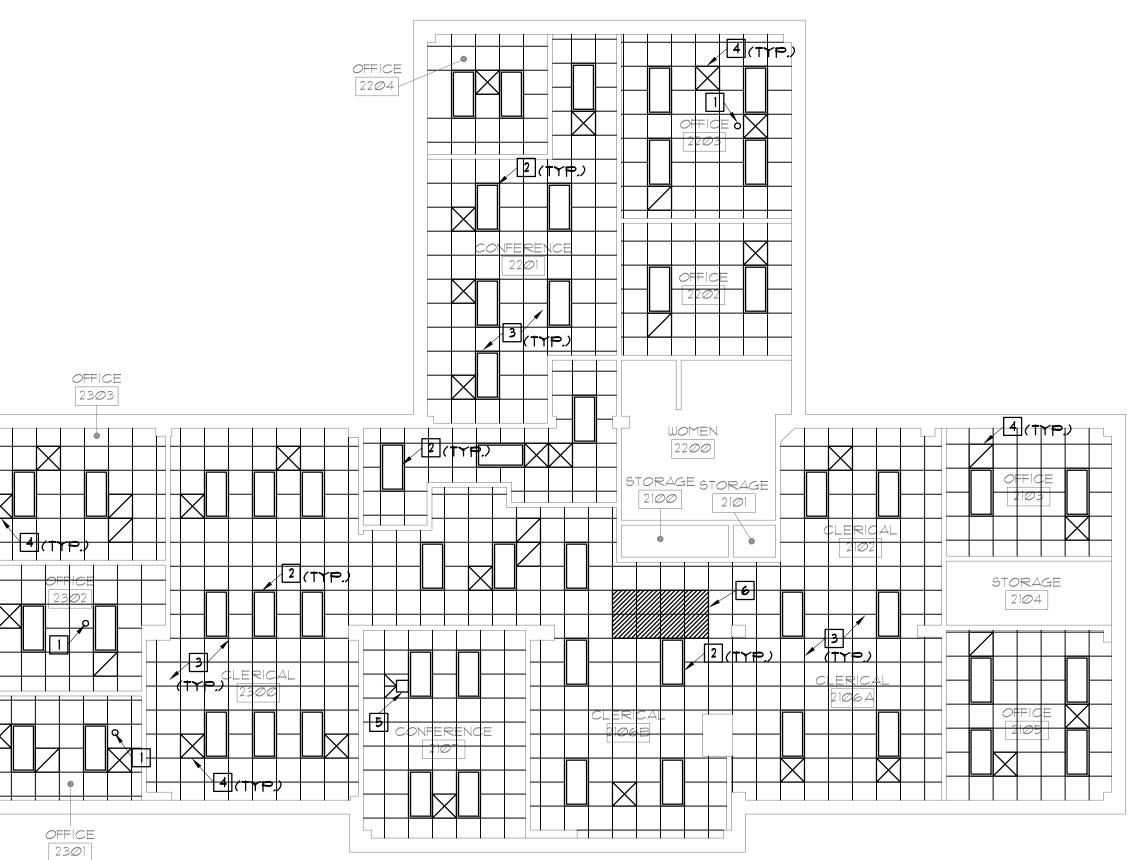

NEW WORK REFLECTED CEILING PLAN

A3 SCALE:1/8" = 1-0"



DEMOLITION NOTES:

- 1) EXISTING PROJECTOR TO BE REMOVED BY THE OWNER MOUNT TO REMAIN.
- 2) REMOVE EXISTING LIGHTING SEE ELECTRICAL DEMO
- 3) REMOVE EXISTING SUSPENDED ACQUSTIC CEILING TILES AND GRID IN ALL AREAS IDENTIFIED ON ROOM FINISH SCHEDULE.
- 4) REMOVE EXISTING AIR DIFFUSERS AND SAVE FOR REUSE. SEE MECHANICAL DEMO SHEETS.

NEW WORK NOTES:

- 1 SMOKE DETECTORS AND HEAT DETECTORS SEE ELECTRICAL SHEETS.
- 2 PROVIDE LED LIGHTING SEE ELECTRICAL SHEETS.
- 3 PROVIDE NEW 2' X 2' ACOUSTICAL PANEL CEILING
- 4 PROVIDE DIFFUSERS AND RETURNS SEE MECHANICAL
- 5 OWNER TO REINSTALL THE PROJECTOR
- 6 EXISTING LADDER FOR ACCESSING ATTIC IS LOCATED IN THIS AREA CEILING LAYOUT SHALL BE INSTALLED SO THAT CEILING GRID MAIN RUNNER IS NOT IN THIS LOCATION

GENERAL NOTES:

1. ALL EXISTING CONSTRUCTION / FINISHES DISTURBED DURING CONSTRUCTION SHALL BE RESTORED TO A CONDITION AT LEAST EQUAL IN MATERIAL AND

APPEARANCE TO THAT WHICH EXISTED BEFORE

2. CONTRACTOR SHALL FIELD VERIFY ALL EXISTING

3. DUE TO AGE OF BUILDING IT IS ASSUMED THAT EXISTING PAINTED SURFACES CONTAIN LEAD BASED

ARCHITECT/ENGINEER OF ANY DISCREPANCIES WHICH

PAINT. CONTRACTOR IS RESPONSIBLE FOR INFORMING

COMPLY WITH ALL APPLICABLE STATE AND FEDERAL

ALL ON SITE PERSONNEL OF THIS POTENTIAL AND SHALL

4. EXISTING WALLS WHERE DOORS HAVE BEEN REMOVED

5. WALLS TO RECEIVE PAINT ARE TO BE PREPARED,

PATCHED AND PAINTED FROM CORNER TO CORNER

CONNECTED DURING CONSTRUCTION AND RE-USE IN NEW

6. KEEP EXISTING SMOKE AND HEAT DETECTORS

1. ALL WIRELESS ROUTERS, NETWORK CABLES, AND

PLACE - SEE ELECTRICAL SHEETS FOR MORE

MISCELLANEOUS NETWORK EQUIPMENT TO REMAIN IN

8. PAINT ALL WALL SURFACES, WOOD BASE BOARD, DOOR FRAMES, CASING, INTERIOR SIDE OF WINDOW SASH IN ALL AREAS IDENTIFIED ON THE ROOM

DIMENSIONS AND CONDITIONS. NOTIFY

ARE TO BE PATCHED AND PAINTED.

MAY AFFECT THE OUTCOME OF THE WORK


CONSTRUCTION BEGAN

REQUIREMENTS.

CEILING INSTALLATION

INFORMATION.

FINISH SCHEDULE.

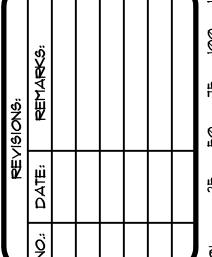

CONSULTANT:

CONSULTING ENGINEERS 00 EAST WASHINGTON, SUITE 220 BELLEVILLE, IL 62220 TEL 618.277.5200 FAX 618.277.5227

SIGNED: 12-22-16 ARC ARC

EXPIRES: 11-30-2018 DATE: 12/22/16

ALP CHECK:

N

MGN MGN PROJECT PHASE:

DOCUMENTS AAIC PROJECT NUMBER 16011

SHEET NUMBER:

OF 10 SHEETS

ELECTRICAL SYMBOLS

CEILING-MOUNTED JUNCTION BOX (4"X4"X1-1/2" MIN.)

WALL-MOUNTED JUNCTION BOX (4"X4"X1-1/2" MIN.)

PANEL BOARD LOCATION ON PLANS. "CL21" INDICATES CL21 **2222** DESIGNATION. SHEET KEYED NOTE. "1" INDICATES NOTE NUMBER.

DIGITAL LIGHTING CONTROL WALLSTATION. MOUNT AT 48" A.F.F. U.N.O. "CR" INDICATES WALLSTATION DESIGNATION. SEE LIGHTING CONTROL SCHEDULE FOR ADDITIONAL INFORMATION.

SHEET DEMOLITION KEYED NOTE. "2" INDICATED NOTE #

FLOOR BOX LOCATION.

CIRCUIT CONDUIT ROUTING. "III" INDICATES (1) GROUND CONDUCTOR, (1) NEUTRAL CONDUCTOR, AND (2) PHASE CONDUCTORS RESPECTIVELY. ")"INDICATES ISOLATED GROUND CONDUCTOR. ALL CONDUCTORS SHALL BE #12 AWG MIN. U.N.O.

CIRCUIT/CONDUIT "HOMERUN"

ELECTRICAL SYMBOLS

LIGHT FIXTURE. "B" INDICATES FIXTURE TYPE. "H21-13" INDICATES PANEL AND CIRCUIT. "a" INDICATES SWITCHLEG. "NL" INDICATES NIGHTLIGHT LOCATION, PROVIDE UNSWITCHED HOT TO FIXTURE LOCATION. "S" PREFIX INDICATES AN EXTERIOR FIXTURE. "DZx" INDICATES DAYLIGHT ZONE FIXTURE IS IN. TYPICAL OF ALL LIGHT FIXTURES. SEE LIGHT FIXTURE SCHEDULE FOR MORE INFORMATION.

DOWNLIGHT

GRID-MOUNTED LIGHT FIXTURE. SIZE AS INDICATED.

PROVIDE FIXTURE WITH EMERGENCY BATTERY BACK-UP. SYMBOL TYPICAL OF ALL LIGHT FIXTURES. PROVIDE UNSWITCHED PHASE CONDUCTOR TO EACH EMERGENCY BATTERY ON SAME PHASE AS LIGHT FIXTURE.

WALL-MOUNTED LIGHT FIXTURE

EXIT LIGHT FIXTURE. " H" INDICATES WALL-MOUNTED. PROVIDE WITH ARROWS AS INDICATED. SHADING INDICATES FACE DIRECTION, SEE PLANS FOR SINGLE- OR DOUBLE-FACE SIGNS.

EXTERIOR WALL PACK. SEAL FIXTURE AT WALL WITH NON-HARDENING WEATHERPROOF SEALANT.

OCCUPANCY SENSOR. "_" INDICATES WALL OR CEILING MOUNTED. ARROW INDICATES CANOPY-MOUNTED SENSOR WITH DIRECTIONAL COVERAGE. "-A-" INDICATES SENSOR TYPE (SEE OCCUPANCY SENSOR SCHEDULE).

DZ1 CEILING MOUNTED PHOTO CELL. "DZ1" INDICATES DAYLIGHT ZONE CONTROLLED BY PHOTO CELL. ZONE CONTROLLED BY PHOTO CELL

FIRE ALARM RATE-OF-RISE HEAT DETECTOR LOCATION

FIRE ALARM SMOKE DETECTOR LOCATION

KEYED NOTES

- (1) DISCONNECT AND REMOVE LIGHT FIXTURE. ASSOCIATED CIRCUIT TO REMAIN IN ROOM FOR CONNECTION TO NEW FIXTURES. SEE SHEET E1.0 FOR MORE INFORMATION.
- 2 DISCONNECT AND REMOVE LIGHT SWITCH AND WIRING. ASSOCIATED BOX AND CONDUIT TO REMAIN FOR NEW LOW VOLTAGE SWITCHES. SEE SHEET E1.0 FOR MORE INFORMATION.
- (3) DISCONNECT AND REMOVE LIGHT SWITCH AND WIRING. ASSOCIATED BOX AND CONDUIT TO REMAIN. PROVIDE COVER PLATE TO MATCH ROOM FINISHES.
- 4 EXISTING EXIT SIGN TO BE DISCONNECT AND RETAIN TO ALLOW FOR RE-INSTALLATION. SEE NEW WORK PLANS FOR MORE INFORMATION. PROTECT SIGN DURING ALL PHASES OF CONSTRUCTION.
- (5) DISCONNECT AND REMOVE EXISTING EMERGENCY FIXTURE AND ALL ASSOCIATED WIRING AND CONDUIT. MAINTAIN CONTINUITY TO ALL EXISTING TO REMAIN DEVICES, BEYOND FIXTURE.
- 6 DISCONNECT AND REMOVE EXISTING WALL PACK. RETAIN EXISTING CIRCUIT AND ASSOCIATED BOX AND CONDUIT. MAINTAIN CONTINUITY TO ALL EXISTING TO REMAIN DEVICES, BEYOND DEVICE.
- (7) MAKE DEVICE SAFE FOR REMOVAL. DEVICE REMOVAL TO BE DONE BY ABATEMENT CONTRACTOR, COORDINATE SCHEDULE WITH THE ABATEMENT CONTRACTOR. MAINTAIN CONTINUITY TO ALL EXISTING TO REMAIN DEVICES, BEYOND DEVICE.

(8) NO ELECTRICAL DEMOLITION WORK IN ROOM.



45. 45. aicil 618,


SIGNED: 12-22-16

EXPIRES: 11-30-2017 12-22-2016

ERR CHECK: ERR ERR PROJECT PHASE:

DOCUMENTS AAIC PROJECT NUMBER: 16011 SHEET NUMBER:

COPYRIGHT 2008 by AAIC, INC.

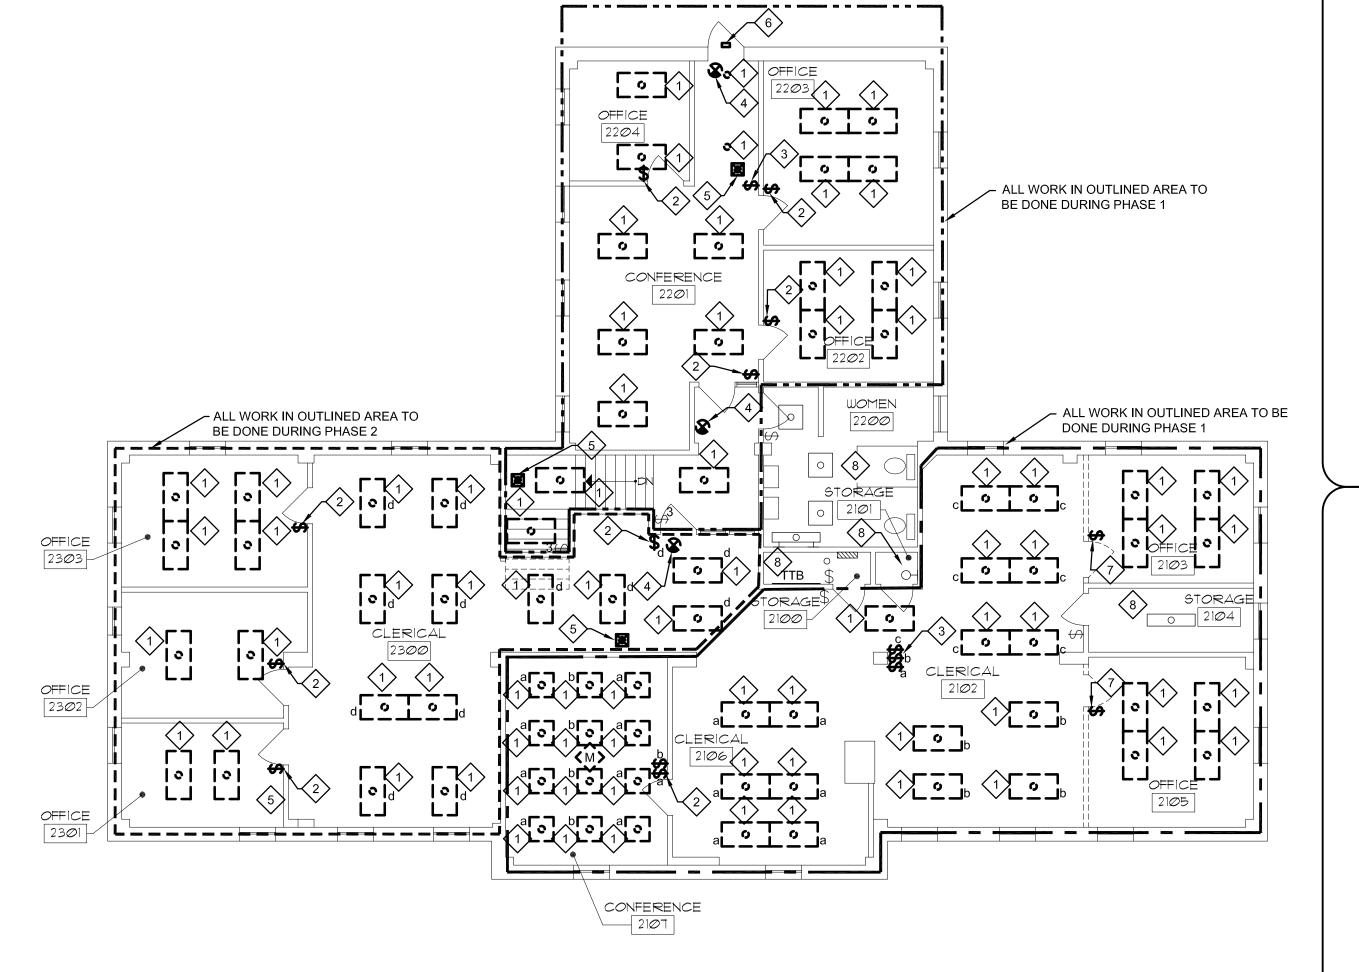




- 1. ALL EXISTING CONDITIONS INDICATED WITHIN THESE DOCUMENTS ARE BASED ON AVAILABLE INFORMATION AND CASUAL FIELD OBSERVATIONS VERIFY EXACT FIELD CONDITIONS (QUANTITIES, LOCATIONS, ETC) PRIOR TO BEGINNING WORK.
- 2. ALL DEVICES AND EQUIPMENT SHOWN BOLD AND DISCONNECTED, REMOVED AND DISPOSED OF BY THE EC, UNLESS OTHERWISE INDICATED. THE OWNER SHALL BE GIVEN SALVAGE RIGHTS TO ALL EQUIPMENT INDICATED FOR REMOVAL WITHOUT RE-INSTALLATION. EC SHALL DISPOSE OF ALL UN-SALBAGED EQUIPMENT IN AN ENVIRONMENTALLY ACCEPTABLE MANNER.
- 3. ALL DEVICES SHOWN LIGHT AND SOLID ARE TO REMAIN, UNLESS OTHERWISE INDICATED.
- 4. PROTECT ALL FINISHES NOT SCHEDULED FOR DEMOLITION.
- 5. CONTRACTOR SHALL FOLLOW THE PHASING SCHEDULE SET BY THE SCHOOL AND THE ARCHITECT. SEE ARCHITECTURAL SHEET A.1 FOR PHASING PLAN.
- 6. CONTRACTOR SHALL MAINTAIN CONTINUITY TO ALL EXISTING TO REMAIN DEVICES, BEYOND TO REMOVED DEVICE(S).

A3 POWER AND SYSTEMS DEMOLITION PLAN
DE2.0 SCALE: 1/8" = 1'-0"

KEYED NOTES

- 1 EXISTING FIRE ALARM DEVICE TO BE DISCONNECT AND RETAIN TO ALLOW FOR RE-INSTALLATION. SEE NEW WORK PLANS FOR MORE INFORMATION. PROTECT DEVICE DURING ALL PHASES OF CONSTRUCTION. MAINTAIN CONTINUITY TO ALL EXISTING TO REMAIN DEVICES, BEYOND REMOVED DEVICE.
- 2 EXISTING CEILING SPEAKER TO BE TEMPORALLY SUPPORTED WHILE CEILING IS BEING REMOVED AND REINSTALLED IN NEW CEILING. SEE NEW WORK PLANS FOR MORE INFORMATION. PROTECT THE SPEAKER DURING ALL PHASES OF CONSTRUCTION.
- 3 EXISTING FLOOR BOX TO REMAIN. FLOOR AROUND BOX IS TO BE REMOVED, BY OTHERS. PROTECT FLOOR BOX DURING ALL PHASES OF CONSTRUCTION. SEE SHEET E2.0 FOR MORE INFORMATION.
- 4 MAKE DEVICE SAFE FOR REMOVAL. DEVICE REMOVAL TO BE DONE BY ABATEMENT CONTRACTOR. COORDINATE SCHEDULE WITH THE ABATEMENT CONTRACTOR. MAINTAIN CONTINUITY TO ALL EXISTING TO REMAIN DEVICES, BEYOND REMOVED DEVICE.
- (5) NO ELECTRICAL DEMOLITION WORK IN ROOM.
- 6 LOCATION OF EXISTING CEILING MOUNTED PROJECTOR. PROJECTOR TO BE REMOVED BY SCHOOL.
- 7 EXISTING BASE BOARD HEATER TO BE DISCONNECTED BEFORE EXISTING FLOOR IS TO BE REMOVE. HEATER TO BE REINSTALLED, SEE NEW WORK PLANS FOR MORE INFORMATION. HEATER TO BE PROTECT DURING ALL PHASES OF CONSTRUCTION. MAINTAIN CONTINUITY TO ALL EXISTING TO REMAIN DEVICES, BEYOND REMOVED DEVICE.

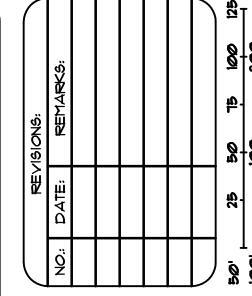

CONSULTANT: PARTNERSHIP, LLC CONSULTING ENGINEERS

100 EAST WASHINGTON, SUITE 220 BELLEVILLE, IL 62220 TEL 618.277.5200 FAX 618.277.5227

SIGNED: 12-22-16 EXPIRES: 11-30-2017

12-22-2016 ERR CHECK: APP:

ERR ERR PROJECT PHASE:

DOCUMENTS AAIC PROJECT NUMBER: 16011 SHEET NUMBER:


COPYRIGHT 2008 by AAIC, INC.

GENERAL NOTES

1. ALL EXISTING CONDITIONS INDICATED WITHIN THESE DOCUMENTS ARE BASED ON AVAILABLE INFORMATION AND CASUAL FIELD OBSERVATIONS VERIFY EXACT FIELD CONDITIONS (QUANTITIES, LOCATIONS, ETC) PRIOR TO BEGINNING WORK.

2. ALL DEVICES AND EQUIPMENT SHOWN BOLD AND DASHED ON THIS SHEET ARE TO BE DISCONNECTED, REMOVED AND DISPOSED OF BY THE EC, UNLESS OTHERWISE INDICATED. THE OWNER SHALL BE GIVEN SALVAGE RIGHTS TO ALL EQUIPMENT INDICATED FOR REMOVAL WITHOUT RE-INSTALLATION. EC SHALL DISPOSE OF ALL UN-SALBAGED EQUIPMENT IN AN ENVIRONMENTALLY ACCEPTABLE MANNER.


- 3. ALL DEVICES SHOWN LIGHT AND SOLID ARE TO REMAIN, UNLESS OTHERWISE INDICATED.
- 4. PROTECT ALL FINISHES NOT SCHEDULED FOR DEMOLITION.
- 5. CONTRACTOR SHALL FOLLOW THE PHASING SCHEDULE SET BY THE SCHOOL AND THE ARCHITECT. SEE ARCHITECTURAL SHEET A.1 FOR PHASING PLAN.
- 6. CONTRACTOR SHALL MAINTAIN CONTINUITY TO ALL EXISTING TO REMAIN DEVICES, BEYOND TO REMOVED DEVICE(S).

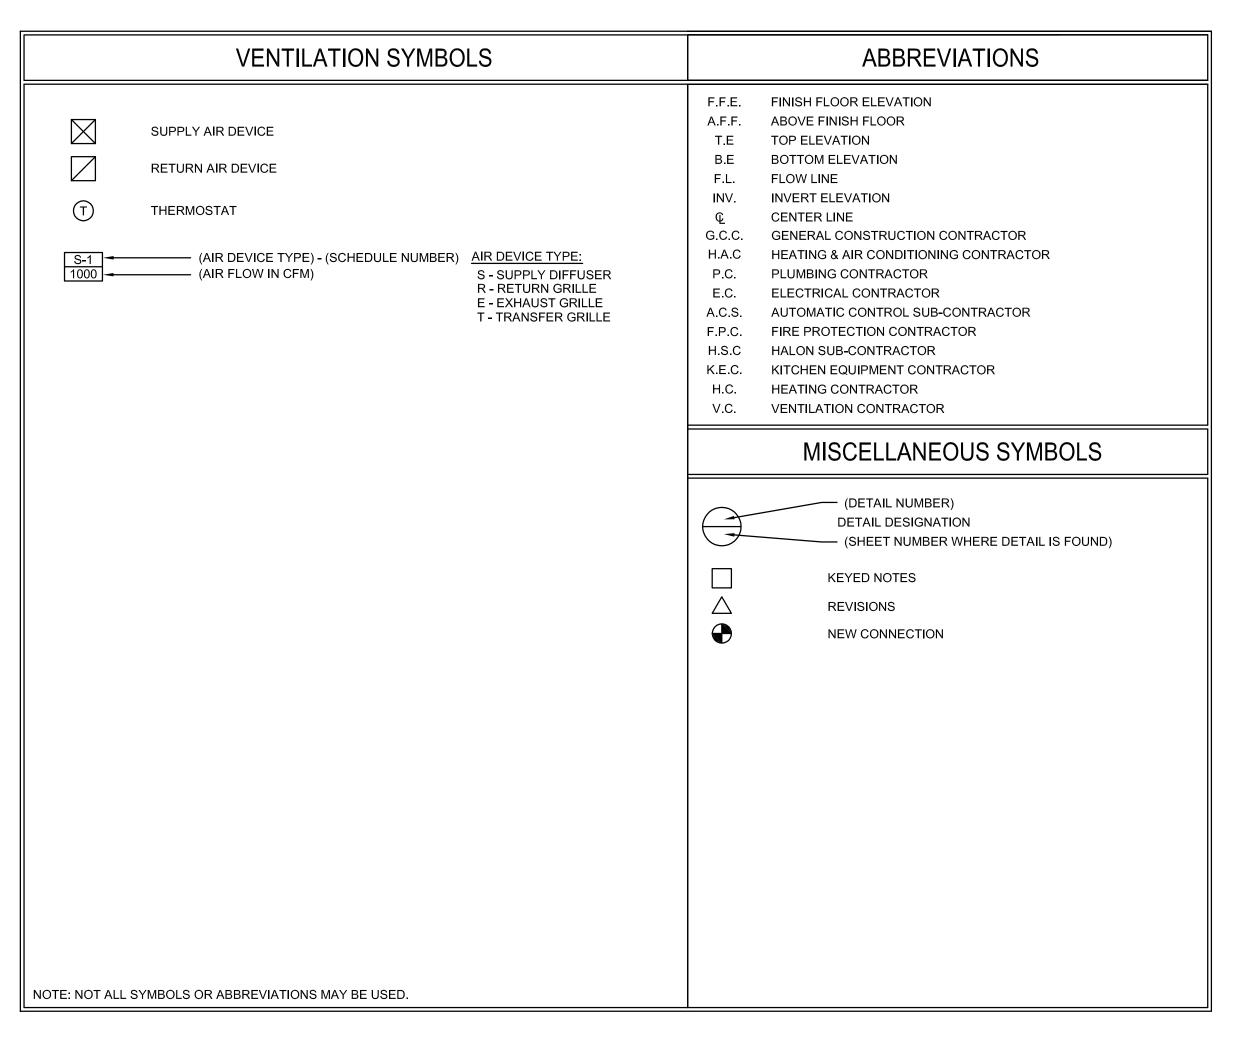

GENERAL NOTES (ALL MECHANICAL SHEETS)

- 1. THESE PLANS ARE DIAGRAMMATIC IN NATURE SINCE THEY REFLECT ONLY THE AVAILABLE INFORMATION OBTAINED FROM EXISTING PLANS, SPECIFICATIONS, AND FIELD SURVEYS. THE EXACT LOCATION OF EXISTING DUCTWORK, PIPING, AND EQUIPMENT MAY DEVIATE FROM THE LOCATION INDICATED ON THE DRAWINGS. THE CONTRACTOR SHALL BE PREPARED TO MAKE SOME ALTERATIONS TO NEW AND/OR EXISTING SERVICES TO FIT ACTUAL JOB CONDITIONS.
- 2. THE SPACE ALLOWED FOR MECHANICAL (HVAC, PLUMBING, FIRE PROTECTION) AND ELECTRICAL WORK ABOVE THE SUSPENDED CEILING IS CRITICAL AND REQUIRES COORDINATION BETWEEN TRADES. CONTRACTORS SHALL THOROUGHLY FAMILIARIZE THEMSELVES WITH THE ARCHITECTURAL, STRUCTURAL, MECHANICAL, AND ELECTRICAL DRAWINGS PRIOR TO FABRICATION OR INSTALLATION OF ANY MATERIALS. DUCTWORK SHALL BE HUNG AS CLOSE AS POSSIBLE TO THE STRUCTURE ABOVE UNLESS INDICATED OTHERWISE. REWORK OF PIPING, DUCTWORK, EQUIPMENT LOCATION, CONDUIT, ETC. AS A RESULT OF POOR PLANNING, COORDINATION, OR SCHEDULING SHALL BE THE RESPONSIBILITY OF THE CONTRACTOR.
- 3. ANY HOLES LEFT IN EXISTING WALL CONSTRUCTION DUE TO DEMOLITION OR NEW WORK SHALL BE PATCHED TO MATCH EXISTING CONDITIONS.
- 4. INSTALL H.V.A.C. SYSTEM IN ACCORDANCE WITH ALL STATE AND LOCAL CODES.
- ALL ITEMS INCLUDED ON THESE DRAWINGS AND THE SPECIFICATIONS SHALL BE INCLUDED IN THE CONTRACTOR'S BID. IF THE CONTRACTOR DOES NOT CLEARLY UNDERSTAND THESE PLANS OR IS NOT SURE OF THEIR MEANING, THE CONTRACTOR SHOULD OBTAIN THE ENGINEER'S WRITTEN EXPLANATION AND INTERPRETATION PRIOR TO BID TIME. THE CONTRACTOR WILL BE HELD TO THE INTERPRETATION OF THE ENGINEER.

- ALL DUCTWORK SHALL BE CONSTRUCTED AND INSTALLED PER THE LATEST VERSION OF THE S.M.A.C.N.A. H.V.A.C. DUCT CONSTRUCTION STANDARDS, UNLESS SPECIFIED MORE STRINGENTLY IN THESE CONSTRUCTION DOCUMENTS.
- ALL NEW DUCT CONNECTIONS TO EXISTING DUCTWORK SHALL BE SEALED
- THE CONTRACTOR SHALL COORDINATE SYSTEM SHUT-DOWNS WITH THE OWNER. PROVIDE A MINIMUM TWO DAY NOTICE PRIOR TO ANY SYSTEM SHUT-DOWN.
- INSTALL ALL DEVICES, DUCTWORK, ETC., LEVEL AND PLUMB.
- WHERE AIR DEVICES ARE INDICATED TO BE REINSTALLED, CONTRACTOR SHALL PUSH AIR DEVICE AND ASSOCIATED DUCTWORK ABOVE THE CEILING AND PROTECT UNTIL READY FOR REINSTALLATION. CONTRACTOR SHALL INFORM BOTH A/E/ AND GENERAL CONTRACTOR OF DEFECTS PRIOR TO DEMOLITION. ANY DEFECT AFTER THAT POINT WILL BE CONTRACTOR'S RESPONSIBILITY TO REPAIR OR REPLACE AT OWNER'S DISCRETION.
- CONTRACTOR SHALL FOLLOW THE SCHEDULE SET BY THE SCHOOL AND THE ARCHITECT. SEE ARCHITECTURAL SHEET A.1 FOR PHASING SCHEDULE.

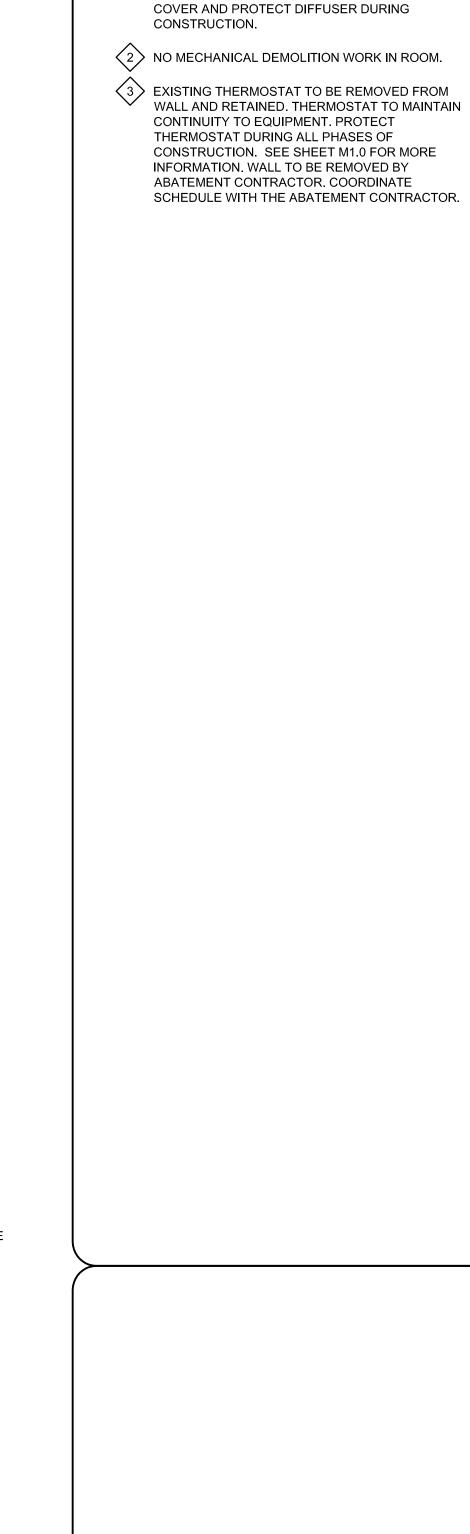


KEYED NOTES


(1) AIR DIFFUSER TO BE PUSHED UP ABOVE

EXISTING CEILING. AIR DIFFUSER TO BE

WORK SHEETS FOR MORE INFORMATION.

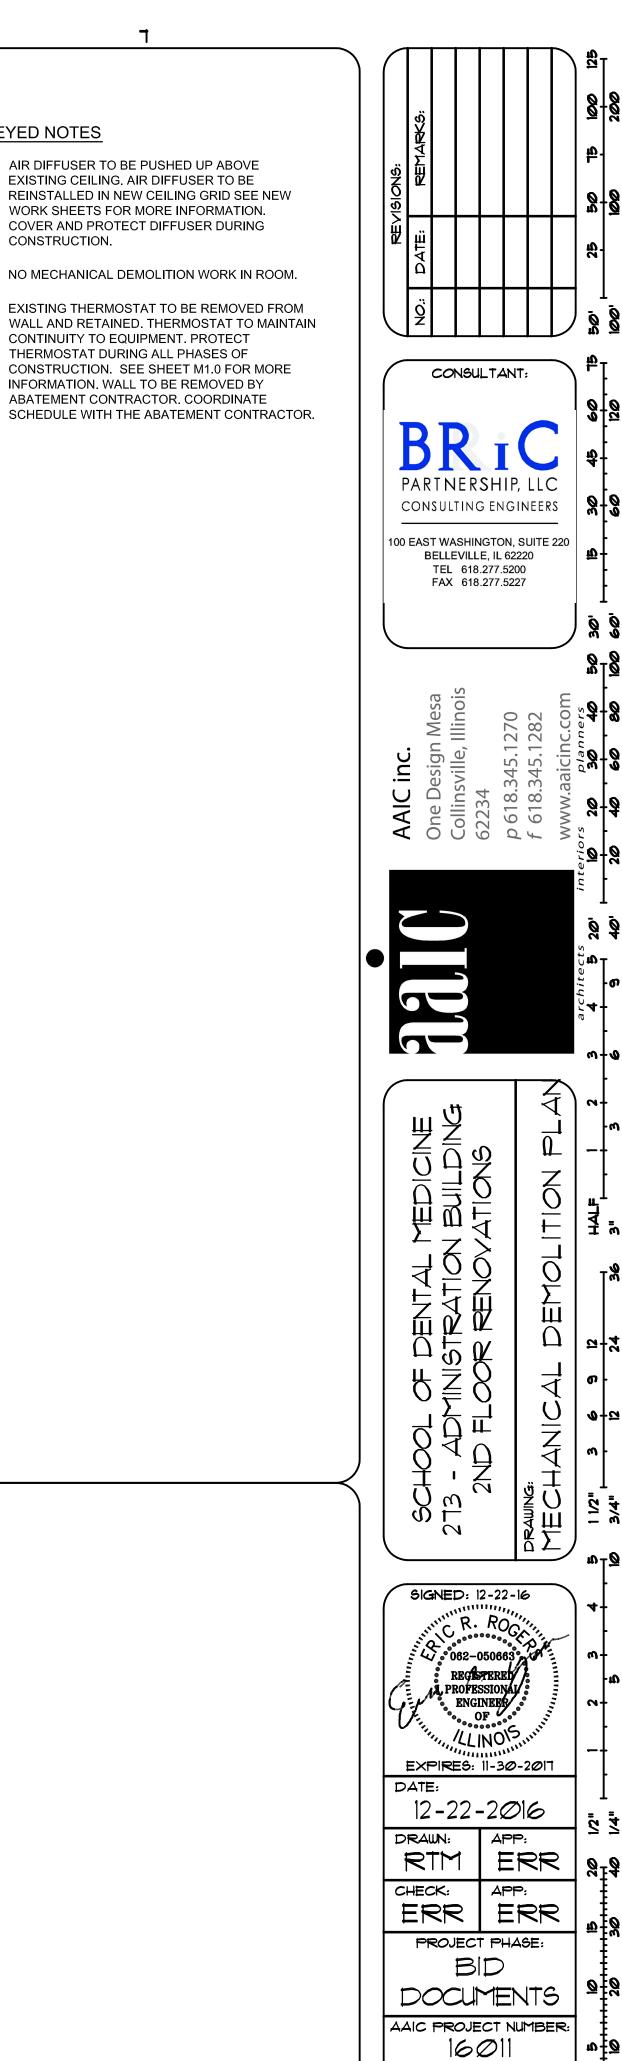

SHEET NUMBER:

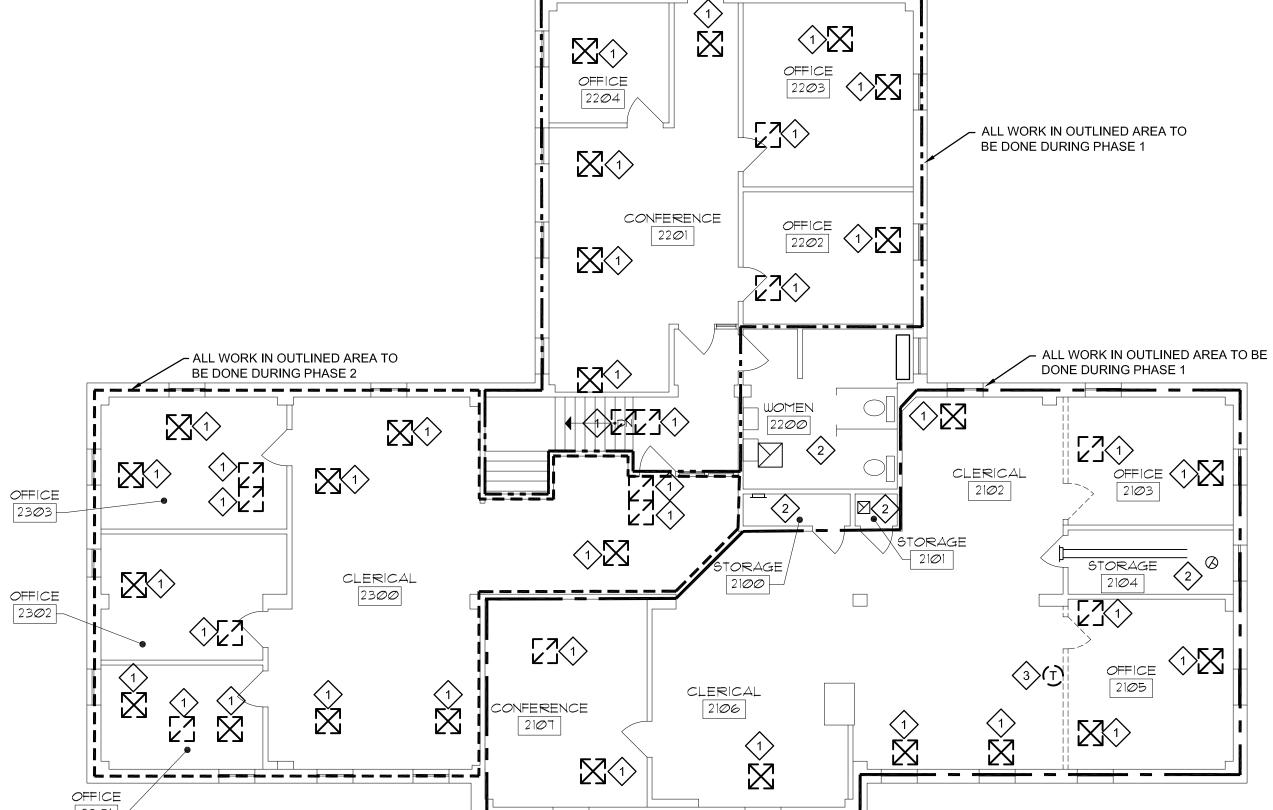




LIGHT FIXTURE SCHEDULE										
TYPE	OPT.	MANUFACTURER & CATALOG No.	VOLTAGE	LAMPS	MOUNTING	DESCRIPTION & REMARKS				
A -	1	METALUX 24AC LD4 39 RDP UNV L835 CD1 U		3900 LUMEN 35W LED 3500 K	CEILING RECESSED					
	2	LITHONIA LIGHTING 2RTL4 40L EZ1 LP835	120			2' x 4' LED RECESSED TROFFER WITH 0-10V DIMMING DRIVER WITH TWO BAR ACRYLIC LENS.				
	3	COLUMBIA LEPC 24 35 LW G LL ED1 U								
	4	APPROVED EQUAL								
AE	1	METALUX 24AC LD4 39 RDP UNV EL14W L835 CD1 U		3900 LUMEN 35W LED 3500 K	CEILING RECESSED					
	2	LITHONIA LIGHTING 2RTL4 40L EZ1 LP835 EL14L	120			2' x 4' LED RECESSED TROFFER WITH 0-10V DIMMING DRIVER WITH TWO BAR ACRYLIC LENS. PROVID WITH INTEGRAL BATTERY PACK.				
^∟	3	COLUMBIA LEPC 24 35 LW G LL ED1 U ELL14								
	4	APPROVED EQUAL								
BE -	1	McGRAW-EDISON ISS E02 LED E1 BL3 BK BBB-120 P TR			WALL MOUNT	EXTERIOR WALL-MOUNTED LED FIXTURE. PROVIDE WITH INTEGRAL BATTERY PACK AND INTEGR				
	2	LITHONIA WSQ LED 2 10A700/40K SR3 120 BBW PE ELCW VG DBLXD	120	5,400 LUMEN 47W LED						
	3	SPAULDING AUATERSPHERE 30L 4K 053 3 U BL BBU	1 120	4000 K		PHOTOCELL.				
	4	APPROVED EQUAL								

	OCCUPANCY SENSOR SCHEDULE								
SENSOR DESIGNATION	TYPE	DESCRIPTION							
-A-	DUAL TECHNOLOGY	CEILING MOUNTED, DUAL TECHNOLOGY, 360 DEGREE COVERAGE.							


3


LIGHTING CONTROL SCHEDULE										
PLAN SPACE MARK TYPE		ROOMS	EQUIPMENT BUTTON FUNCTION		SEQUENCE OF OPERATION					
OF	OFFICE	2103, 2203	1 - BUTTON WALL STATION TYPE -A- OCCUPANCY SENSORS PHOTO CELL DIMMING POWER PACK	1 - ALL LIGHTS ON, ALL LIGHTS OFF	LIGHTS ARE TO BE VACANCY CONTROLLED. WALL STATION PROVIDES MANUAL ON AND OVERRIDE OFF FOR ALL FIXTURES. AFTER SPACE IS UNOCCUPIED FOR 10 MINUTES, ALL LIGHTS TURN OFF AUTOMATICALLY. PHOTOCELL SHALL AUTOMATICALLY DIM DAYLIGHT ZONES AS REQUIRED TO MAINTAIN 45 FC LIGHT LEVEL.					
os	SMALL ROOM	2103, 2202, 2204, 2301, 2302, 2303	DUAL-TECHNOLOGY WALL SENSOR DIMMING POWER PACK	1 - ALL LIGHTS ON, ALL LIGHTS OFF	LIGHTS ARE TO BE VACANCY CONTROLLED. WALL STATION PROVIDES MANUAL ON AND OVERRIDE OFF OF ALL LIGHTS. AFTER SPACE IS UNOCCUPIED FOR 10 MINUTES, ALL LIGHTS TURN OFF AUTOMATICALLY.					
CF	CONFERENCE ROOM	2107	4 - BUTTON WALL STATION TYPE -A- OCCUPANCY SENSORS PHOTO CELL DIMMING POWER PACK	1 - ALL LIGHTS ON 2 - ALL LIGHTS OFF 3 - ALL LIGHTS RAISE 4 - ALL LIGHTS LOWER	OCCUPANCY SENSOR PROVIDES AUTO ON TO 50% OUTPUT. AFTER SPACE IS UNOCCUPIED FOR 10 MINUTES, ALL LIGHTS TURN OFF AUTOMATICALLY. WALL STATION PROVIDES MANUAL DIMMING AND OVERRIDE OFF FOR ALL FIXTURES. PHOTOCELL SHALL AUTOMATICALLY DIM DAYLIGHT ZONES AS REQUIRED TO MAINTAIN 45 FC LIGHT LEVEL.					
OP	OPEN OFFICE	2102, 2106, 2201, 2300	4 - BUTTON WALL STATION TYPE -A- OCCUPANCY SENSORS PHOTO CELL DIMMING POWER PACK	1 - ALL LIGHTS ON 2 - ALL LIGHTS OFF 3 - ALL LIGHTS RAISE 4 - ALL LIGHTS LOWER	OCCUPANCY SENSOR PROVIDES AUTO ON TO 50% OUTPUT. AFTER SPACE IS UNOCCUPIED FOR 30 MINUTES, ALL LIGHTS TURN OFF AUTOMATICALLY. WALL STATION PROVIDES MANUAL DIMMING AND OVERRIDE OFF FOR ALL FIXTURES. PHOTOCELL SHALL AUTOMATICALLY DIM DAYLIGHT ZONES AS REQUIRED TO MAINTAIN 45 FC LIGHT LEVEL.					

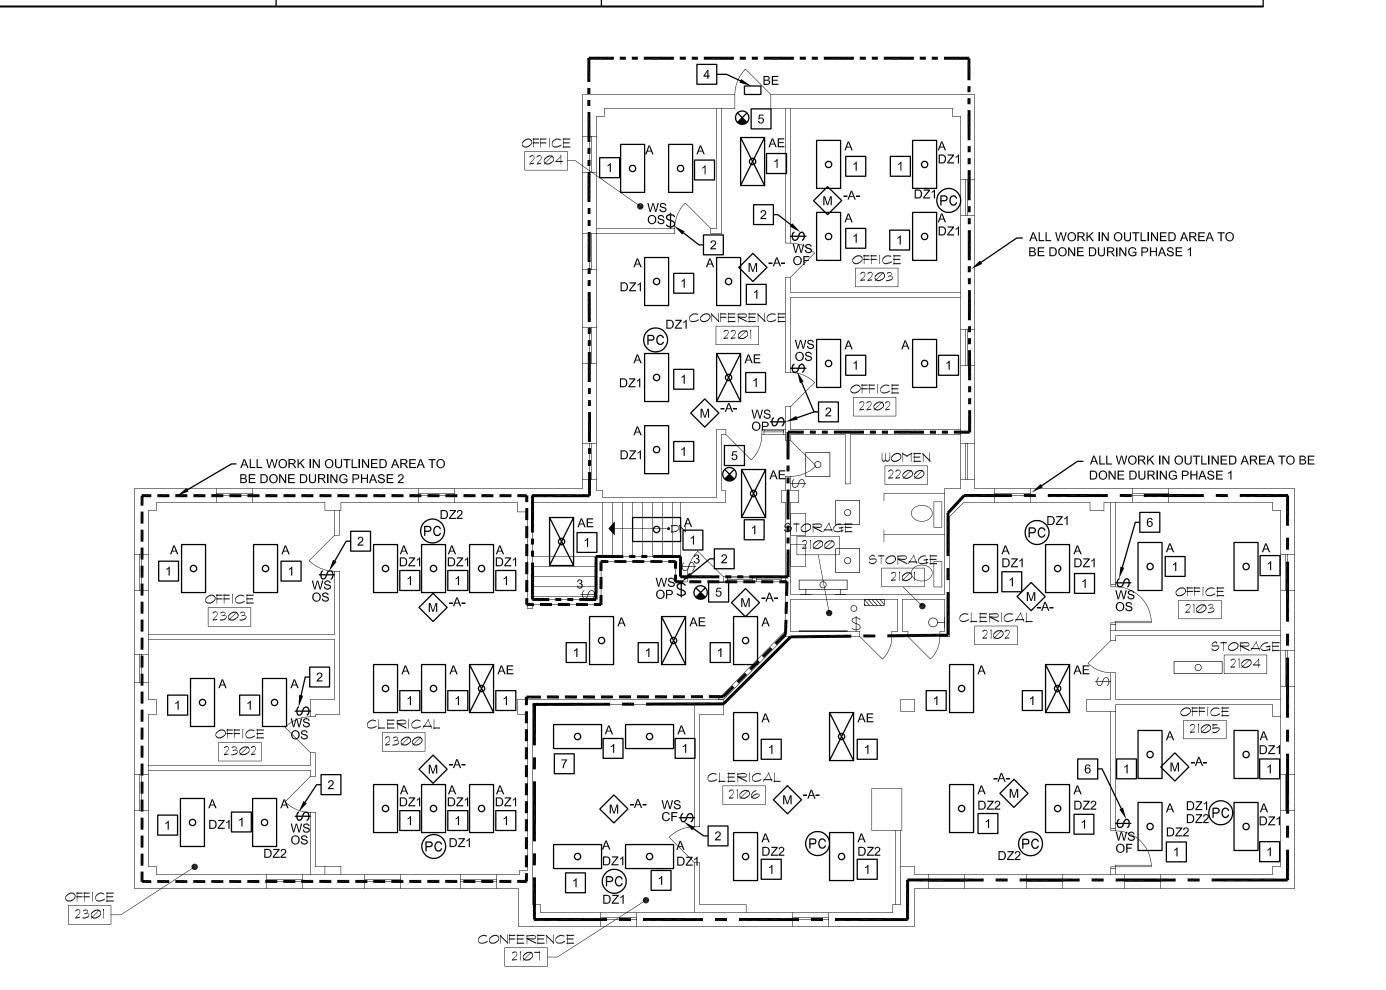

A3 LIGHTING NEW WORK PLAN EI.0 SCALE: 1/8" = 1'-0"



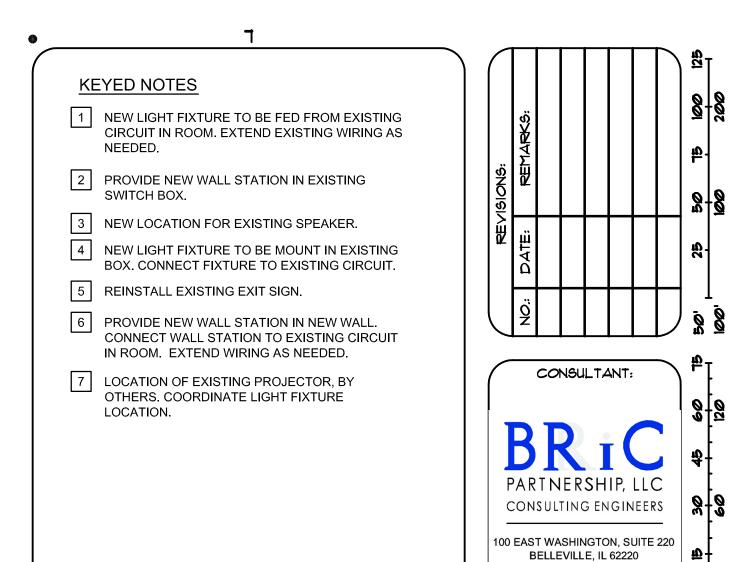

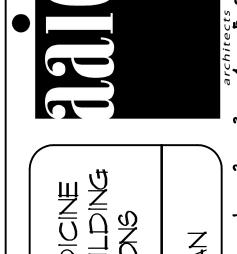

TEL 618.277.5200 FAX 618.277.5227



GENERAL NOTES

BREAKER.

MORE INFORMATION.

PHASING PLAN.

FOR MORE INFORMATION.

WHEN AN EXISTING CIRCUIT IS INDICATED TO BE REUSED, THE CONTRACTOR SHALL VERIFY EXISTING CIRCUIT CAPACITY AND CONNECT A

2. SEE LIGHT FIXTURE SCHEDULE, THIS SHEET, FOR

3. SEE LIGHTING CONTROL SCHEDULE, THIS SHEET

4. SEE OCCUPANCY SENSOR SCHEDULE, THIS

CONTRACTOR SHALL FOLLOW THE PHASING SCHEDULE SET BY THE SCHOOL AND THE

ARCHITECT. SEE ARCHITECTURAL SHEET A.1 FOR

SEE DETAIL H3/E2 FOR TYPICAL LIGHTING WIRING DIAGRAM - SWITCHING CONTROLLER.

7. SEE DETAIL E1/E2 FOR TYPICAL LIGHTING WIRING

8. SEE DETAIL H1/E2 FOR TYPICAL WIRING DEVICE DETAIL.

DIAGRAM - DIMMING CONTROLLER.

SHEET, FOR MORE INFORMATION.


TOTAL OF NOT MORE THAN 16 AMPS ON A 20 AMP

CHECK: ERR ERR PROJECT PHASE:

DOCUMENTS 16011 SHEET NUMBER:

AAIC PROJECT NUMBER:

COPYRIGHT 2008 by AAIC, INC.

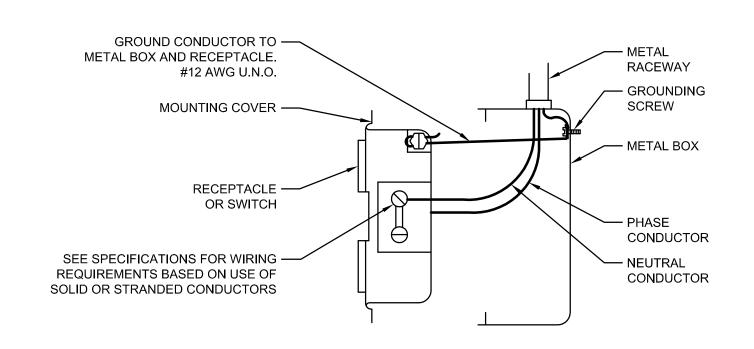


CAT 5e - ROOM OCCUPANCY SENSOR DATALINE (QTY AS INDICATED) CABLE (TYP) LIGHTING ➤ DAYLIGHT ZONE PHOTOCELL - ROOM WALL SWITCH (QTY AS INDICATED) CIRCUIT IN ROOM (QTY AS INDICATED) → DIMMING ROOM CONTROLLER CAT 5e – DATALINE FIXTURE WITH INTEGRAL BATTERY CABLE (TYP) ON PLANS


GENERAL NOTE: BASIS OF DESIGN IS WATTSTOPPER DIGITAL LIGHTING MANAGEMENT. SEE FLOOR PLANS, SPECIFICATIONS, AND LIGHTING CONTROLS SCHEDULE FOR ADDITIONAL INFORMATION.

HI TYPICAL WIRING DEVICE DETAIL E2.0) SCALE: NO SCALE

TYPICAL LIGHTING WIRING DIAGRAM - DIMMING CONTROLLER
E2.0 SCALE: NO SCALE

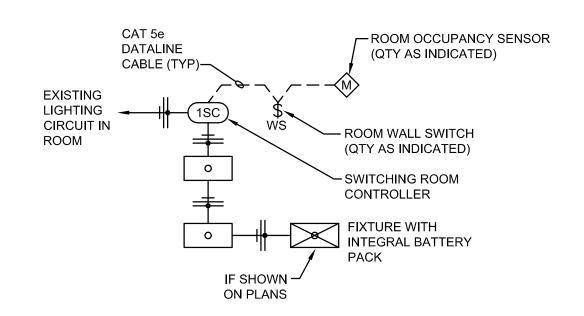

GENERAL NOTE: BASIS OF DESIGN IS WATTSTOPPER DIGITAL LIGHTING MANAGEMENT. SEE FLOOR PLANS, SPECIFICATIONS, AND LIGHTING

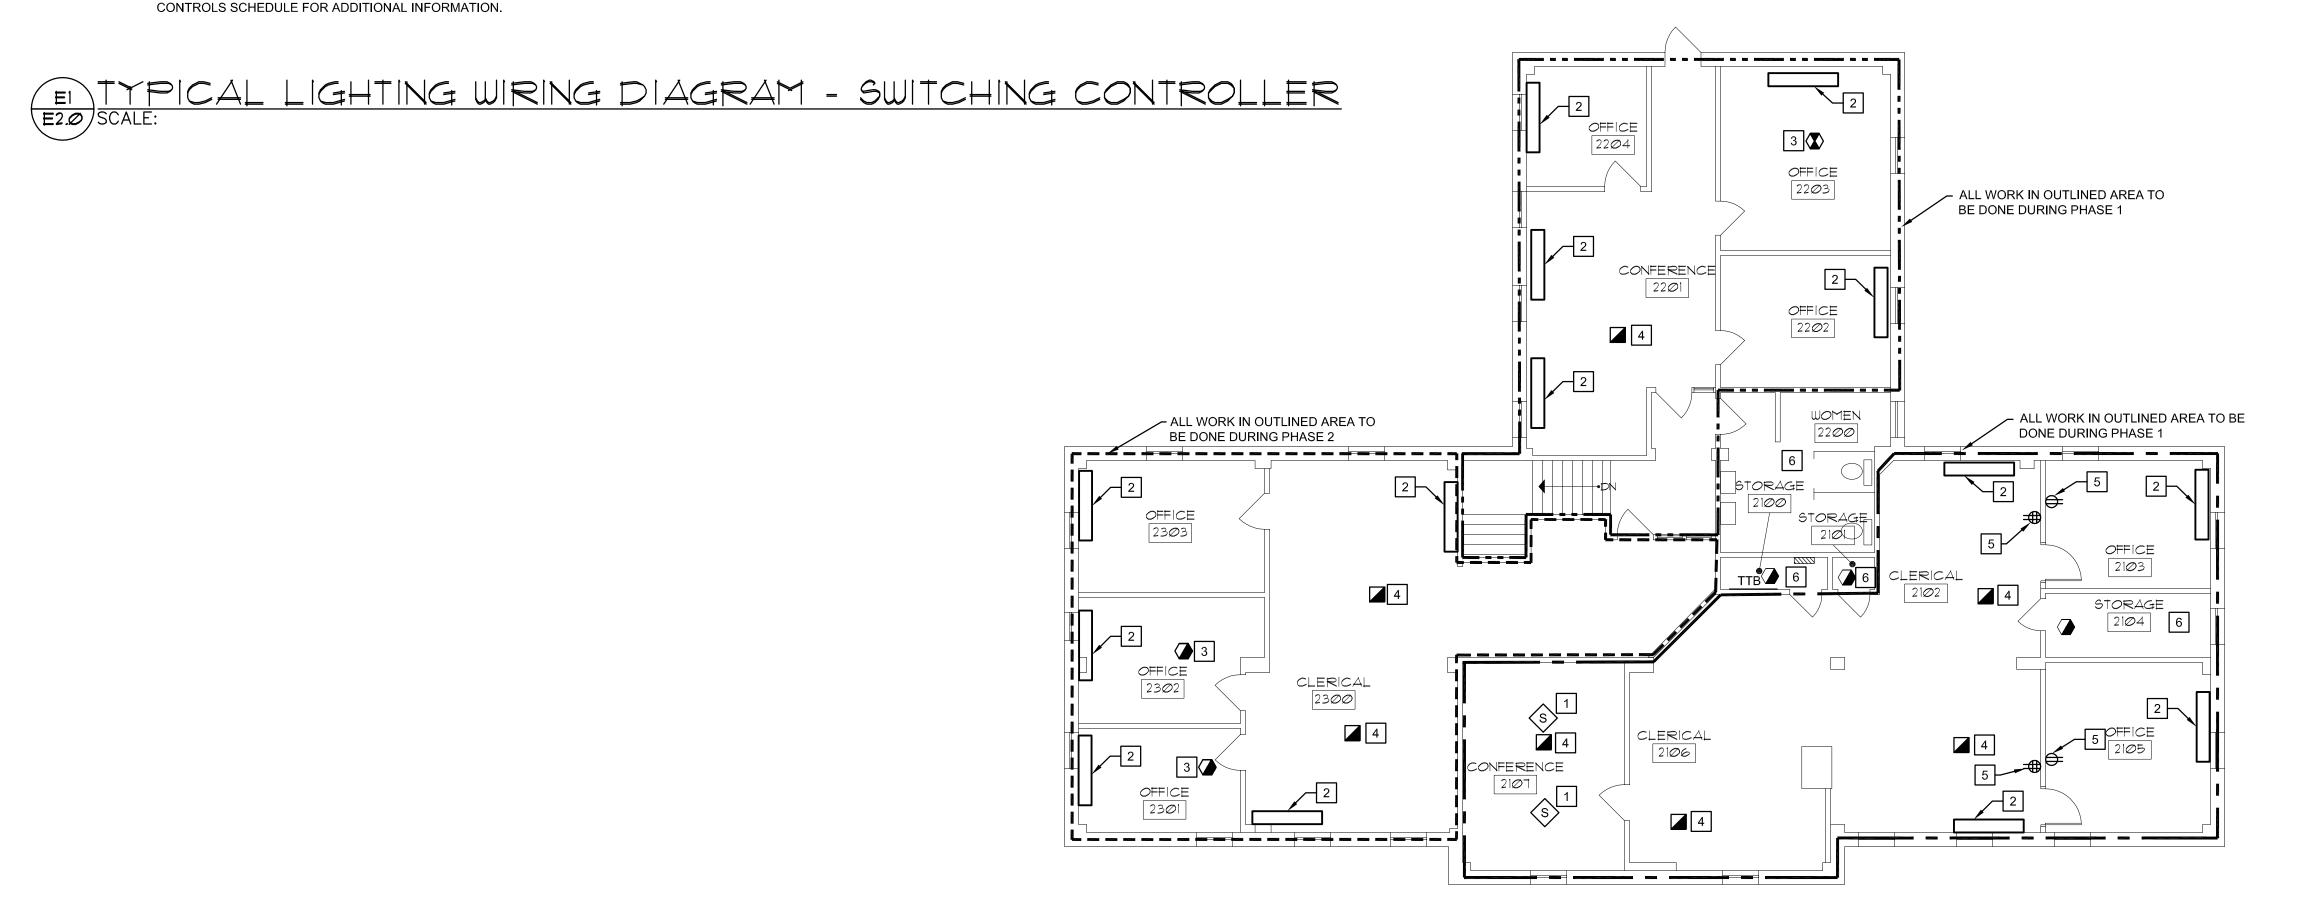





- 1 NEW LOCATION FOR EXISTING SPEAKER.
- 2 REINSTALL EXISTING ELECTRIC BASE BOARD HEATER TO EXISTING CIRCUIT. EXTEND WIRING AS NEEDED.
- REINSTALL EXISTING FIRE ALARM DEVICE. EXTEND WIRING AS NEEDED.
- 4 EXISTING FLOOR BOX TO BE MADE FLUSH WITH NEW FLOOR. COORDINATE NEW HEIGHT WITH FLOORING INSTALLER BEFORE NEW CONCRETE IS POURED. EXTEND WIRING AS NEEDED.
- 5 CONNECT NEW ELECTRICAL DEVICE TO EXISTING CIRCUIT. EXTEND WIRING AS NEEDED.
- 6 NO NEW POWER AND SYSTEMS WORK IN THIS ROOM.

REVISIONS:
NO.: DATE: REMARKS.
5 50 75 100

BRIC
PARTNERSHIP, LLC
CONSULTING ENGINEERS

100 EAST WASHINGTON, SUITE 220 BELLEVILLE, IL 62220 TEL 618.277.5200 FAX 618.277.5227

> Design Mesa nsville, Illinois 34 8.345.1270 8.345.1282

AAIC ING
One Desig
Collinsvill
62234
p 618.345
f 618.345

ADMINISTRATION BUILD
OF RENOVATIONS
AND SYSTEMS NEW

SIGNED: 12-22-16

R. ROGANIAN

OG2-050663

REGISTERED

PROFESSIONAL

ENGINEER

OF

OF

DATE:

DATE:

12-22-2016

DRAWN: APP:
RTM ERR

CHECK: APP:
ERR ERR

PROJECT PHASE:
BID

DOCUMENTS

BID
DOCUMENTS

AAIC PROJECT NUMBER:
16011

SHEET NUMBER:

<u>=</u>2.C


OF 10 SHEETS

GENERAL NOTES

1. WHEN AN EXISTING CIRCUIT IS INDICATED TO BE REUSED, THE CONTRACTOR SHALL VERIFY EXISTING CIRCUIT CAPACITY AND CONNECT A TOTAL OF NOT MORE THAN 16 AMPS ON A 20 AMP

2. CONTRACTOR SHALL FOLLOW THE PHASING SCHEDULE SET BY THE SCHOOL AND THE ARCHITECT. SEE ARCHITECTURAL SHEET A.1 FOR PHASING PLAN.

SEE DETAIL H1/E2 FOR TYPICAL WIRING DEVICE DETAIL.

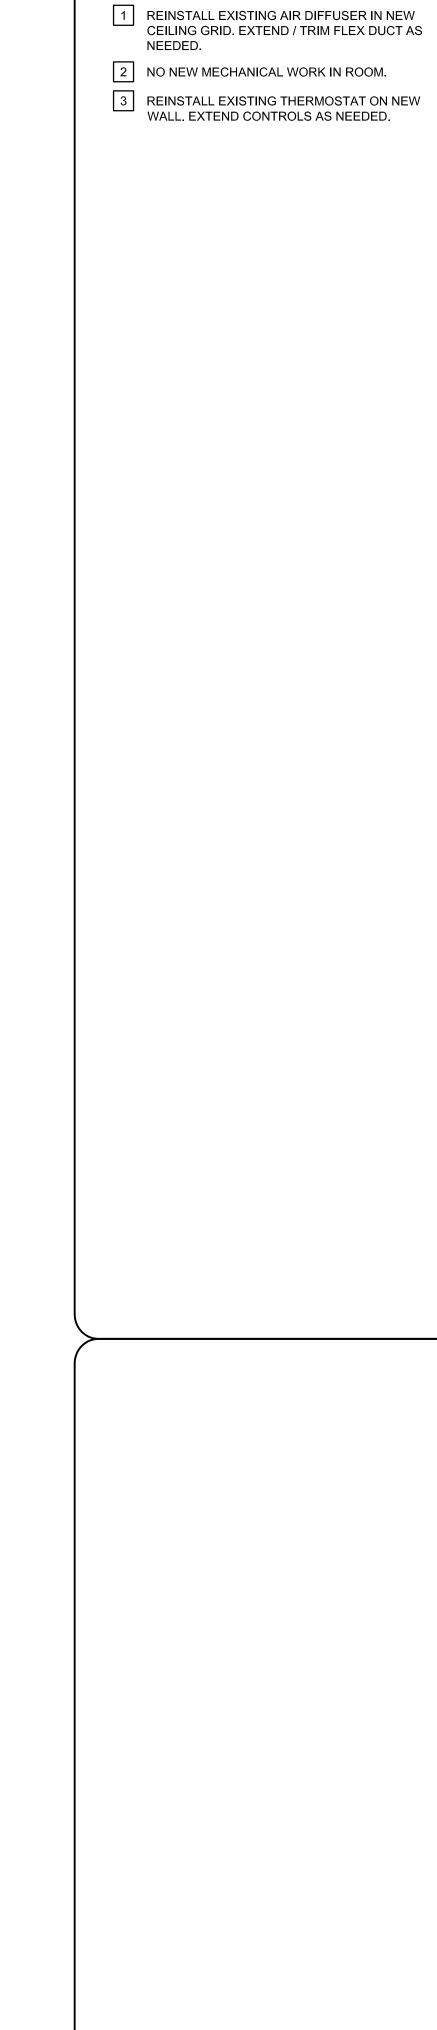

KEYED NOTES CONSULTANT: CONSULTING ENGINEERS 2+3 100 EAST WASHINGTON, SUITE 220 BELLEVILLE, IL 62220 TEL 618.277.5200 FAX 618.277.5227 SIGNED: 12-22-16 CHECK: ERR ERR

2

3

12-22-2016 ERR

SHEET NUMBER:

COPYRIGHT 2008 by AAIC, INC.

EXPIRES: 11-30-2017

PROJECT PHASE: DOCUMENTS AAIC PROJECT NUMBER: